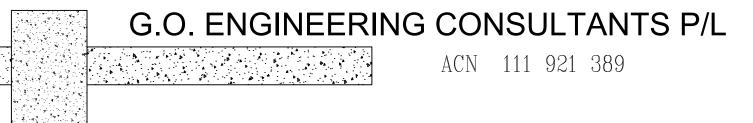
# STRUCTURAL ALTERATIONS AT SOUTHERN ALP SKI LODO CHARLOTTE PASS, NSW 2624



STRUCTURAL DRAWING LIST		
SHEET NO.	REVISION	TITLE
S01	-	COVER
S02	-	SPECIFICATIONS
S03	-	GROUND FLOOR PLAN
S04	-	FIRST FLOOR PLAN
S05	-	SECOND FLOOR PLAN
S06	-	STAIRCASE ELEVATION
S07	-	STAIRCASE DETAILS

GE,	All workmanship and materials to conform with latest edition of the Building Code of Australia and relevant Australian Standards.
,	The contractor is to confirm all dimensions prior to commencing any works on site.
	Refer to specification for other relevant information details.
	G.O. ENGINEERING CONSULTANTS ABN 61 111 921 389 Structural, Civil & Project Management ENGINEERS
	153 Commissioner St Cooma NSW 2630
	Phone: (02) 6452 4699 Fax: (02) 6452 4996 reception@goengineering.com.au
	Drawing Title: STRUCTURAL ALTERATIONS AT SOUTHERN ALP SKI LODGE, CHARLOTTE PASS, NSW 2624
	Client: Tim Moore
	Structural Sheet No. S01 of 7
	Scale:         NTS           Date:         24.03.2022
	Drawing No: 20210316
	COVER Sheet Size:- A3
	Designed: D. Crawford
	Drawn: M. Essa Checked: G Bowland
	Approved:
DRAFT	
	Geoff Bowland MIEAust CPEng ISSUE DATE AMENDMENT INITIALS
TE:- 24.03.2022	This document is Copyright and shall not be copied without written approval, nor shall it be used except for the Development and the Site Specified.

## NOTES:

- 1. All workmanship and materials to conform with the latest edition of the building code of Australia and relevant Australian standards.
- 2. It is not implied or guaranteed that all structural designs and details shown in these plans are complete. The scope of the work has been determined by the Engineer based on the information supplied by the client or the clients consultants. The Engineer will provide further designs if required, but is not responsible for any associated cost where design details have not been specifically requested.
- 3. All dimensions on these plans should be checked on site by the builder and verified using Architectural plans and other contract documents. Discrepancies to be referred to the Architect or Engineer.
- 4. DO NOT SCALE FROM THESE DRAWINGS
- 5. Reference to UNO = Unless Noted Otherwise & NA = Not Applicable.

## SITE CONDITIONS:

1.	Stability/Vegetation -	NA
2.	Drainage -	NA
3.	Soil Type/profile -	NA
4.	AS2870.1 - 2011 site classification -	S
5.	AS4055 - 2011 wind classification N3.0	50m/s (Vh,u).
6.	AS1170.3 - 2002 Roof Design Snow Load for altitude 176	5 m, for roof

#### pitch 10° at CHARLOTTE PASS, NSW 2624 - Sr = 15.7 kPa,

Sg = 17 kPa

## CONCRETE:

- 1. All concrete works to be in accordance with AS3600
- Concrete strength cover and durability details (refer Footings - 25MPa Concrete Slab - 25MPa Core Fill - 25MPa
- 3. All reinforcement to be adequately supported on bar correct positions.
- 4. Concrete to be formed as required by AS3610 and of in accordance with AS3600 and AS3610 to achieve or relevant density durability and strength.
- 5. All reinforced fabric to be lapped one mesh panel plu and reinforcement bars lapped 40 bar diameters, UN

#### FOOTINGS:

1. Footings and slabs on ground designs conform with

### TIMBER:

- 1. All timber construction to comply with Australian Fram AS1684.2 2010.
- 2. Bracing and tie down detail to comply with AS 1684.2
- 3. For external use, use Class 1 or Class 2 HW or Treat

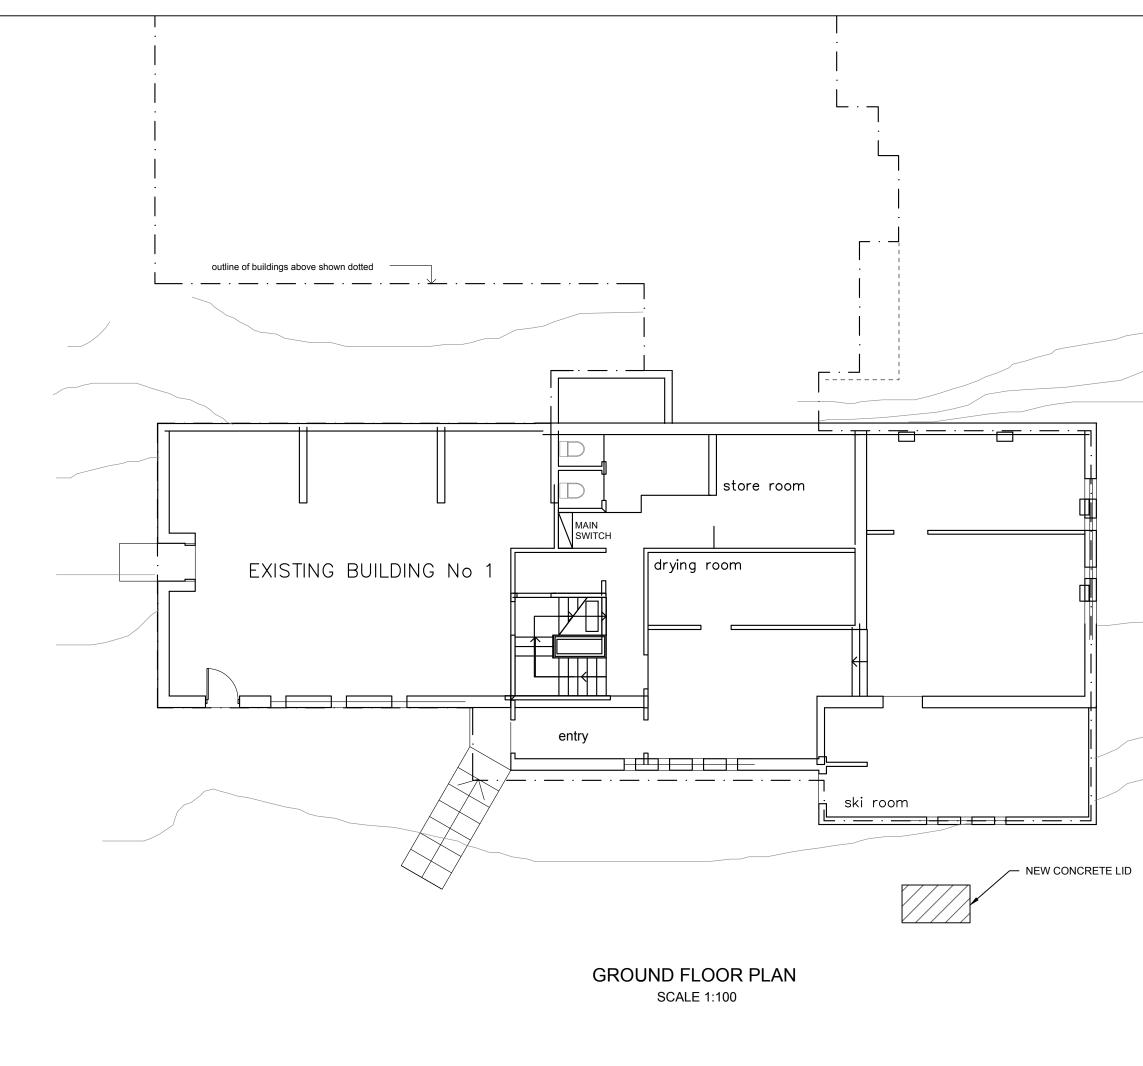
#### STEEL:

1. All steel construction to comply with AS4100 steel str code and AISC Connection Details.

### **BUSH FIRE:**

- 1. BAL 40 Bush fire prone area.
- 2. All construction to comply to AS1530.4 and AS3959.

) 2001	All workmanship and materials to conform with latest edition of the Building Code of Australia and relevant Australian Standards.		
AS3600)	The contractor is to confirm all dimensions prior to commencing any works on site.		
	Refer to specification for other relevant information details.		
chairs in	G.O. ENGINEERING CONSULTANTS ABN 61 111 921 389 Structural, Civil & Project Management ENGINEERS		
compacted specified	153 Commissioner St Cooma NSW 2630		
us 25mm	Phone: (02) 6452 4699 Fax: (02) 6452 4996 reception@goengineering.com.au		
NO. AS 2870-1996.	Drawing Title: STRUCTURAL ALTERATIONS AT SOUTHERN ALP SKI LODGE, CHARLOTTE PASS, NSW 2624		
	Client: Tim Moore		
ning Code	Structural Sheet No. S02 of 7		
2-2010.			
ted Timbers.	Scale: NTS Date: 24.03.2022		
	Drawing No: 20210316		
	SPECIFICATIONS		
ructures	Sheet Size:- A3		
	Designed: D. Crawford Drawn: M. Essa		
	Checked: G Bowland		
	Approved:		
	DRAFT		
	Geoff Bowland MIEAust CPEng		
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All workmanship and materials to conform with latest edition of the Building Code of Australia and relevant Australian Standards.

The contractor is to confirm all dimensions prior to commencing any works on site.

Refer to specification for other relevant information details.

#### G.O. ENGINEERING CONSULTANTS ABN 61 111 921 389 Structural, Civil &

Project Management ENGINEERS

153 Commissioner St Cooma NSW 2630

Phone: (02) 6452 4699 Fax: (02) 6452 4996 reception@goengineering.com.au

Drawing Title: STRUCTURAL ALTERATIONS AT SOUTHERN ALP SKI LODGE, CHARLOTTE PASS, NSW 2624

Client: Tim Moore

Structural Sheet No. S03 of 7

Scale: Date: Drawing No:

AS SHOWN 27.01.2021 20210105

#### SITE PLAN AND PHOTOS

Sheet Size:-Designed:

A3 D. Crawford

M. Essa

G Bowland

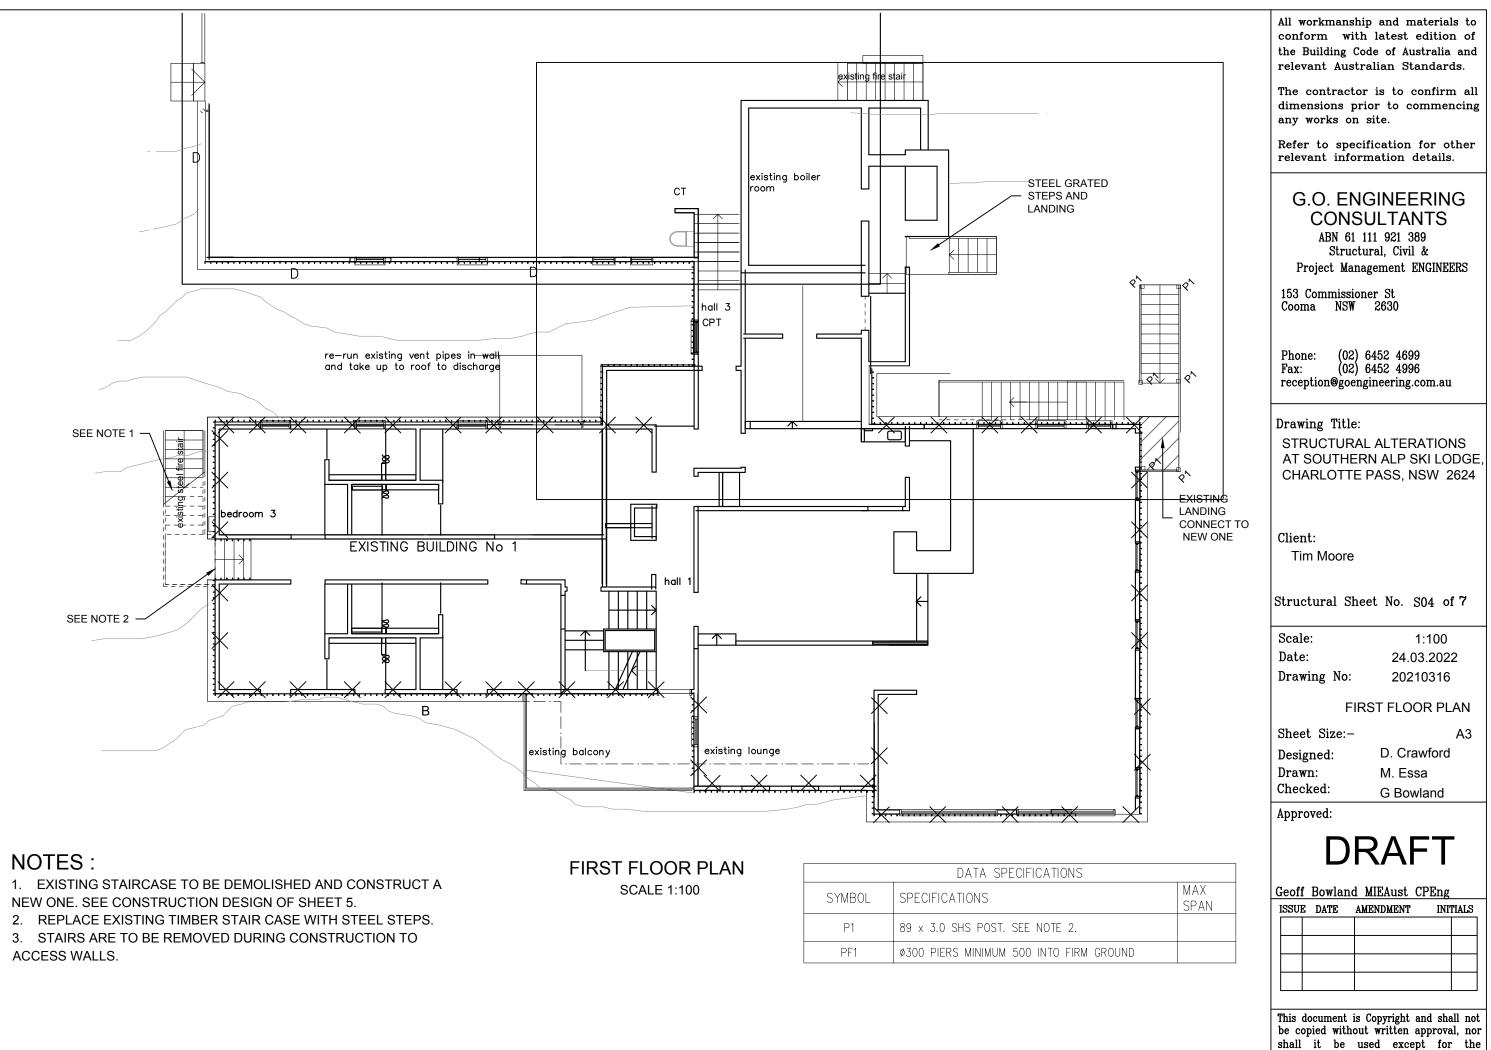
Checked: Approved:

Drawn:

# DRAFT

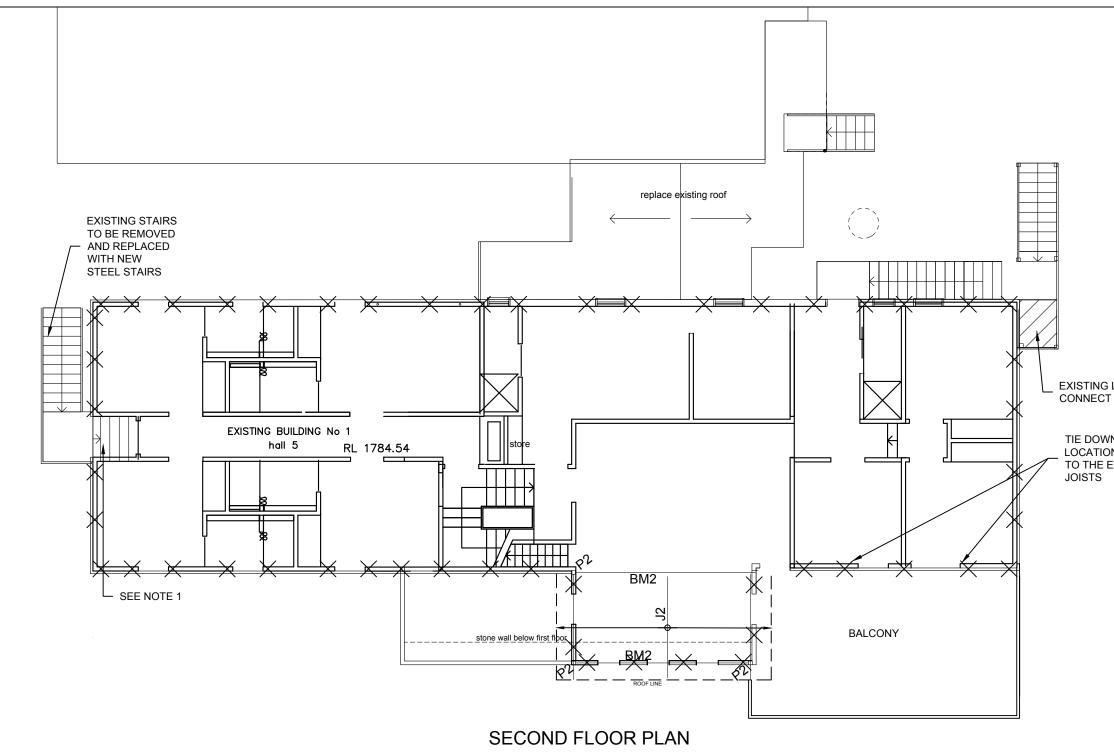
Geoff Bowland MIEAust CPEng
ISSUE DATE AMENDMENT INITIALS

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DATA SPECIFICATIONS	
SYMBOL	SPECIFICATIONS
P1	89 x 3.0 SHS POST. SEE NOTE 2.
PF1	Ø300 PIERS MINIMUM 500 INTO FIRM GROUND

Development and the Site Specified.

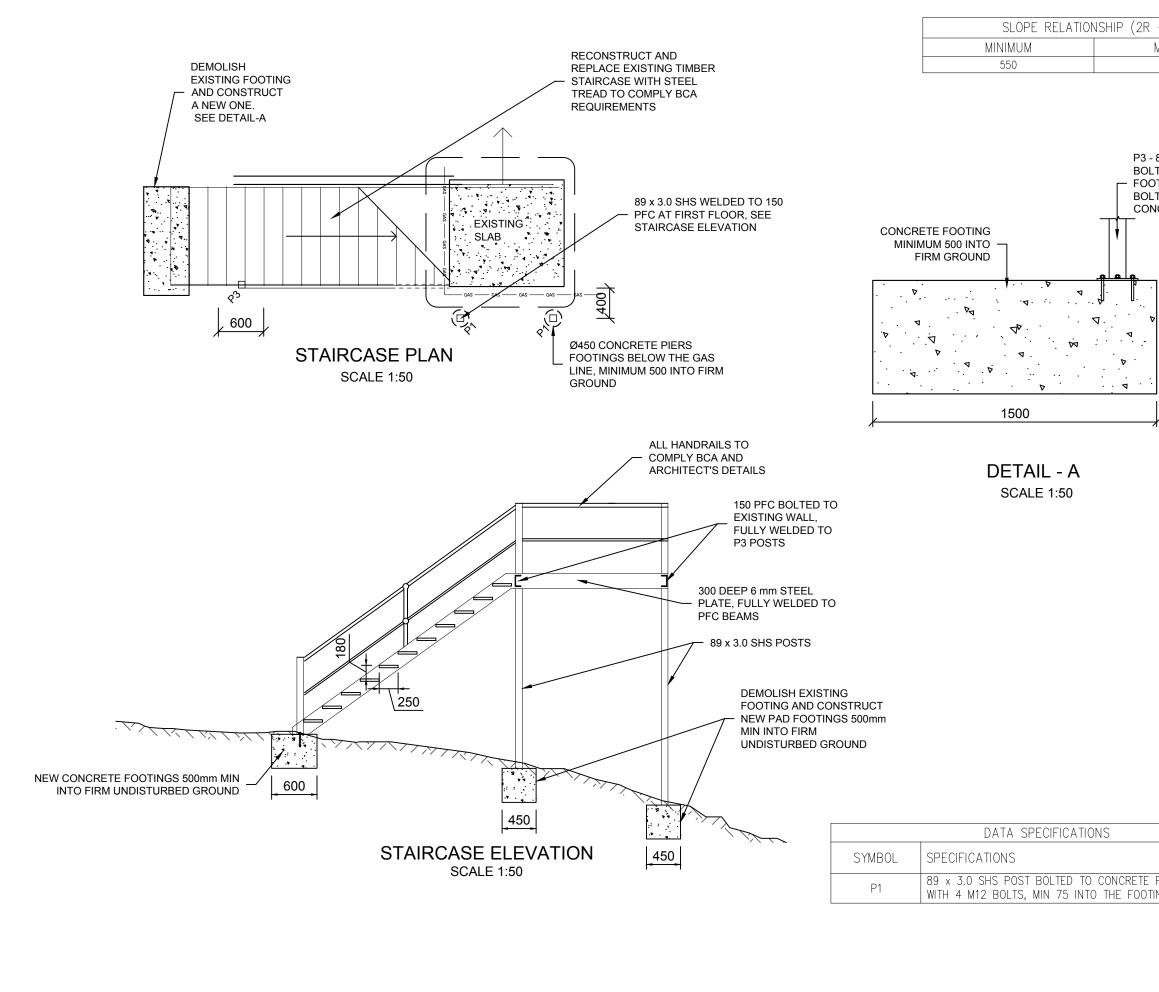


SCALE 1:100

NOTES

1. THE EXISTING FEW STEPS FROM THE BUILDING WILL BE MAINTAINED AND NEW STEEL STAIR WILL START FROM THE LANDING.

	EXISTING LAND CONNECT TO N TIE DOWNS AT LOCATION TO TO THE EXIST JOISTS	EW ONE THIS BE FIXED	All workmanship and materials to conform with latest edition of the Building Code of Australia and relevant Australian Standards. The contractor is to confirm all dimensions prior to commencing any works on site. Refer to specification for other relevant information details. G.O. ENGINEERING CONSULTANTS ABN 61 111 921 389 Structural, Civil & Project Management ENGINEERS 153 Commissioner St Cooma NSW 2630 Phone: (02) 6452 4699 Fax: (02) 6452 4996 reception@goengineering.com.au Drawing Title: STRUCTURAL ALTERATIONS AT SOUTHERN ALP SKI LODGE, CHARLOTTE PASS, NSW 2624 Client: Tim Moore Structural Sheet No. S05 of 7 Scale: 1:100 Date: 24.03.2022 Drawing No: 20210316 SECOND FLOOR PLAN Sheet Size:- A3 Designed: D. Crawford Drawn: M. Essa Checked: G Bowland
	DATA SPECIFICATIONS	MAX	Approved:
SYMBOL	SPECIFICATIONS	SPAN	DRAFT
P2	100 x 5.0 SHS POST FIXED TO THE FIRST FLOOR. SEE NOTE 1.		
J2 BM2	Z150-15 PURLINS @450 CRS         2.3 m           200 UB 29.8 BOLTED TO P2 POSTS         4.6 m		Geoff Bowland MIEAust CPEng ISSUE DATE AMENDMENT INITIALS
X	N12 TIE DOWN RODS CLASS 3 8.8S, SNUG TIGHT OVER THE TOP PLATE AND INTO THE FOOTINGS.		
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+ G) MAXIMUM 700	All workmanship and materials to conform with latest edition of the Building Code of Australia and relevant Australian Standards. The contractor is to confirm all
	dimensions prior to commencing any works on site. Refer to specification for other relevant information details.
89 x 3.0 SHS POST TED TO CONCRETE TING WITH 4 M12 TS MIN 75 INTO ICRETE	G.O. ENGINEERING CONSULTANTS ABN 61 111 921 389 Structural, Civil & Project Management ENGINEERS
	153 Commissioner St Cooma NSW 2630
000	Phone: (02) 6452 4699 Fax: (02) 6452 4996 reception@goengineering.com.au
/ / /	Drawing Title: STRUCTURAL ALTERATIONS AT SOUTHERN ALP SKI LODGE, CHARLOTTE PASS, NSW 2624
	Client: Tim Moore
	Structural Sheet No. S06 of 7
	Scale:         1:50           Date:         24.03.2022           Drawing No:         20210316
	STAIRCASE ELEVATION
	Sheet Size:-A3Designed:D. CrawfordDrawn:M. EssaChecked:G Bowland
	Approved:
MAX SPAN	DRAFT
FOOTING NG	Geoff Bowland MIEAust CPEng ISSUE DATE AMENDMENT INITIALS
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